


TRENCH LAYED  
LEVEL WITH  
CONTOUR OF  
THE LAND.




25m x 90mm  
STORMWATER

TRENCHES NO  
DEEPER THAN 500mm.

NEED TRENCHES SCORZA 20x10mm SHADE CLOTH COVERED

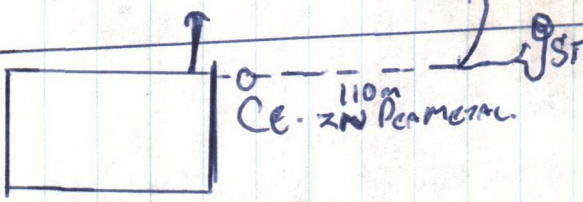

GROUND LEVEL.  
1.25.

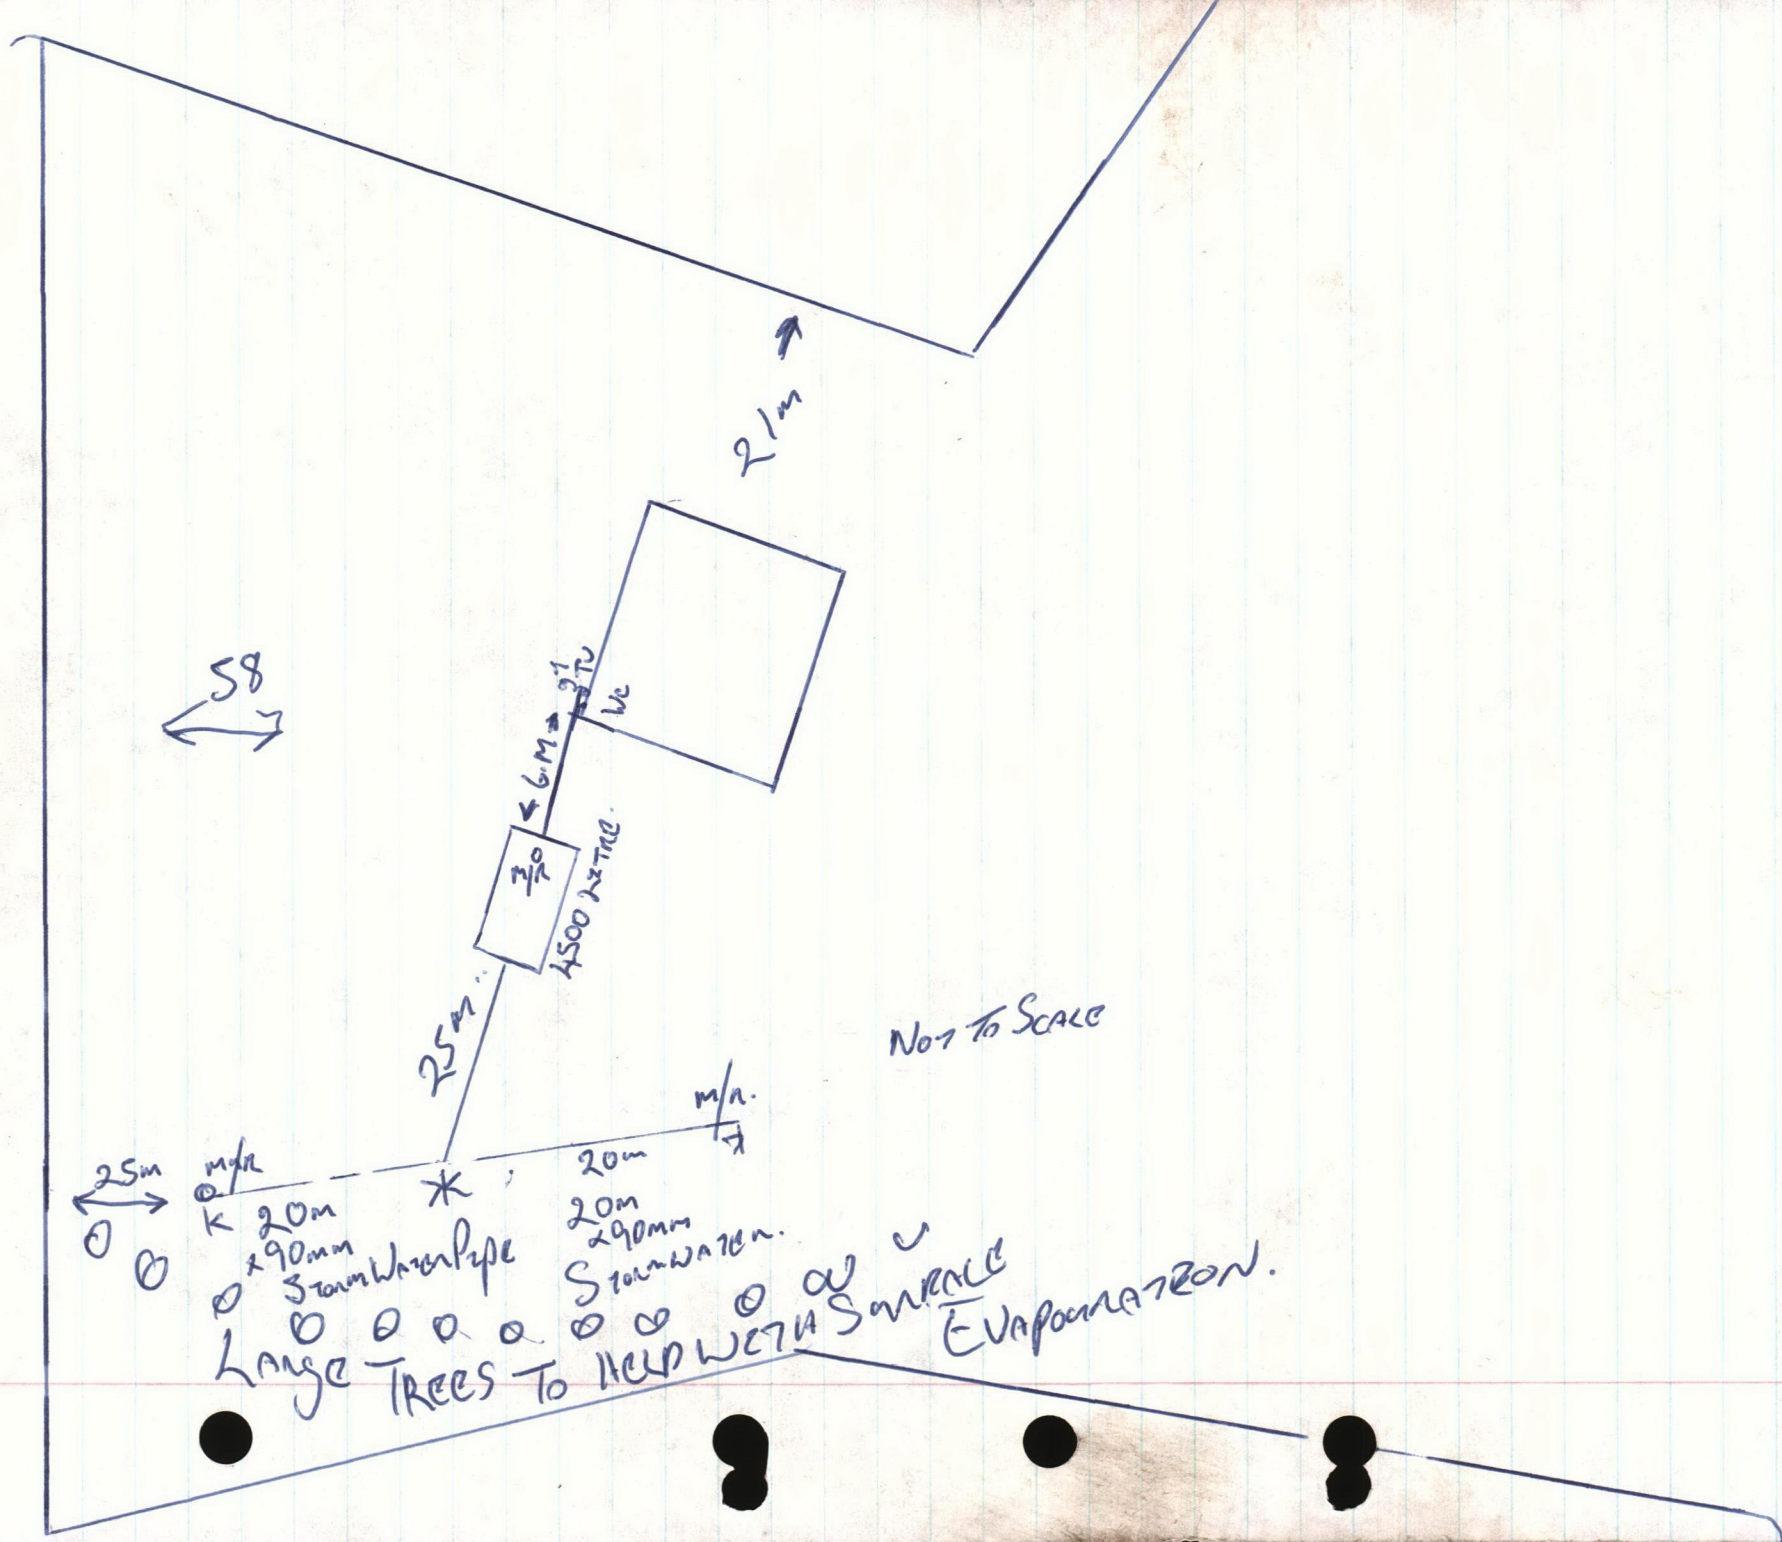

58

21m

25m

NOT TO SCALE

25m

m/a

20m  
20m  
x 90mm  
Storm Water Pipe

20m

20m  
x 90mm  
Storm Water

Large TREES TO HELP WITH SURFACE EVAPORATION.


Steve Amopp

4058765

TRUSS DESIGN FROM KAIHU MILL.

ROOF SPACE IS FOR STORAGE OF SEWING MATERIAL NOT LIVING SPACE.

pryda computa.truss

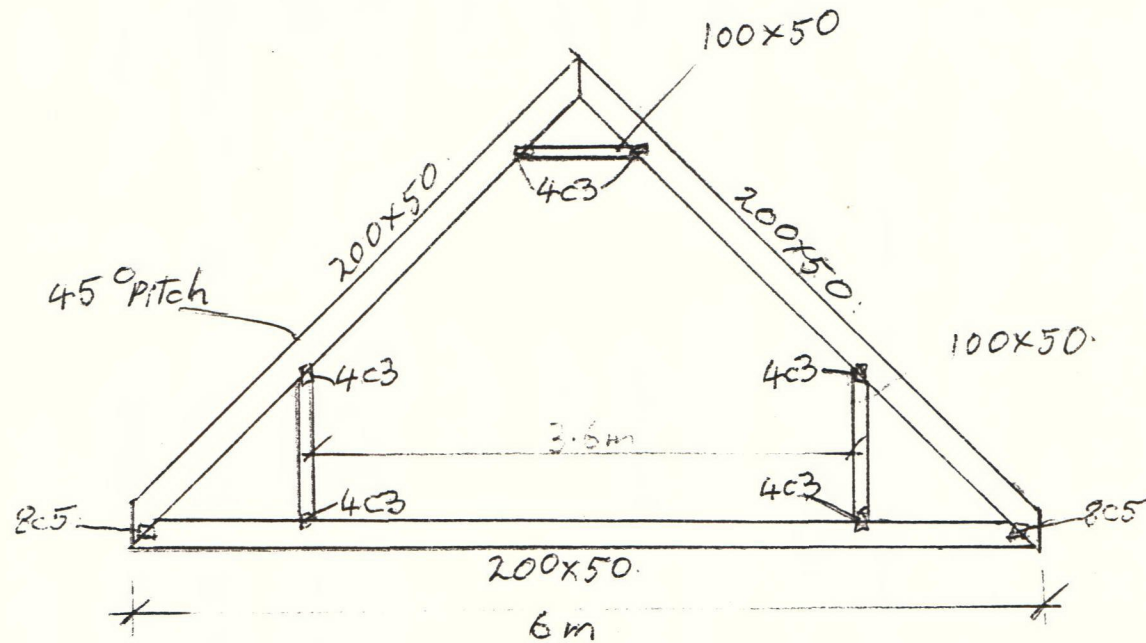

ATTIC TRUSS @ 900mm $\phi$

PINEHILL ROAD.


LOT 1.

POWER SUPPLY

PRIVATE ROAD ACCESS

LOT 2  
2.6134 Ha.

SITE PLAN,  
SCALE 1:1000 Approx

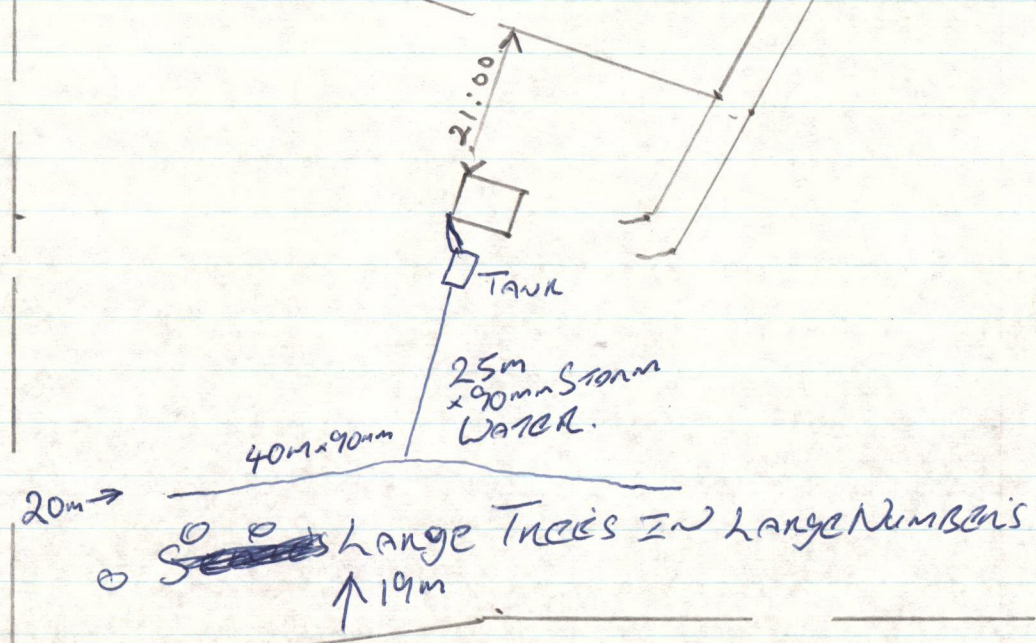

SEND TO F.N.D.C.




*[Faint, illegible handwriting and scribbles on the right page of the notebook.]*




pryda computa-truss

PRELIMINARY

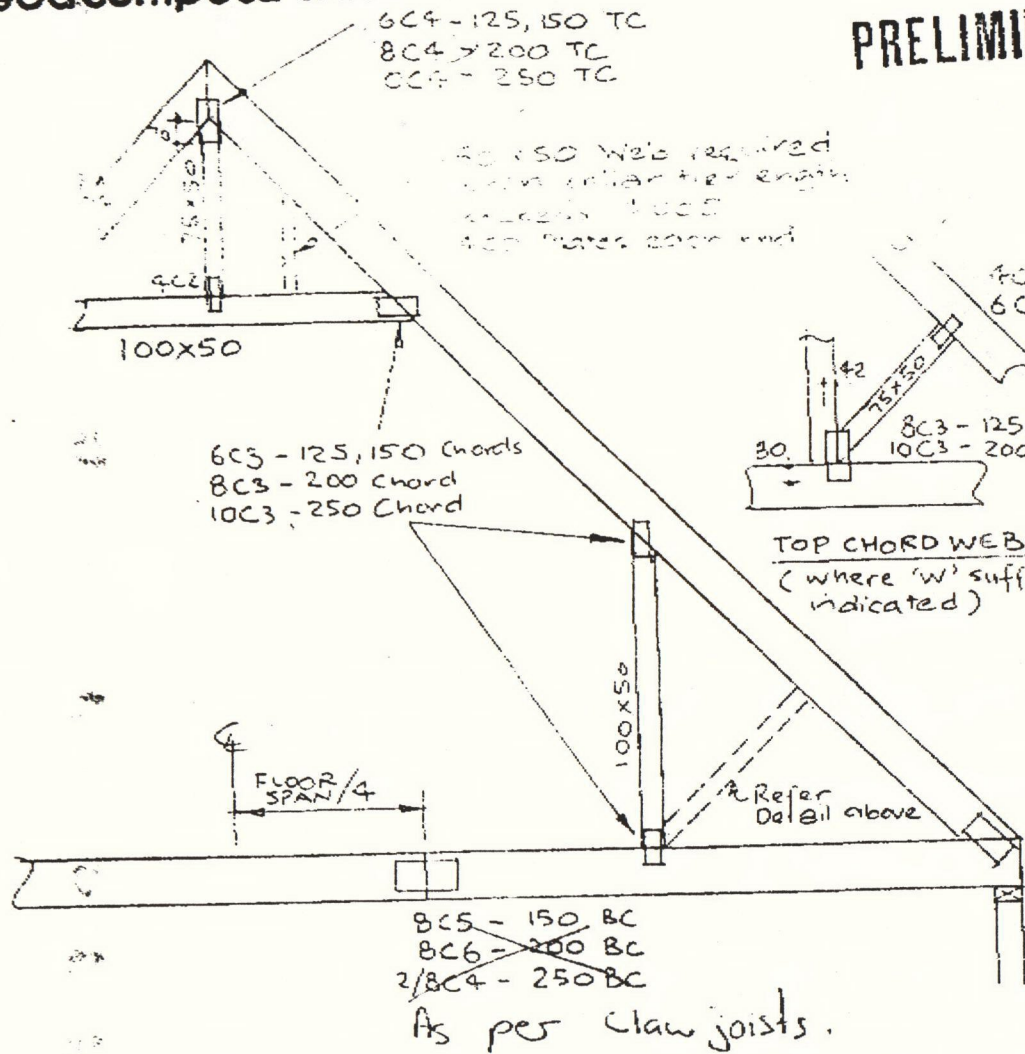


Standard Overhang  
Fixed with 3" d-30's  
100's 200's  
Triggered

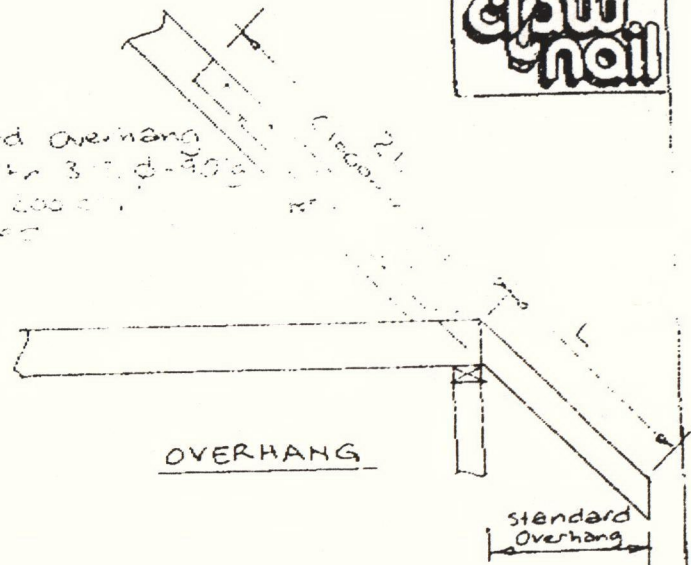

TOP CHORD WEB  
(where 'w' suffix indicated)

HEEL JOINT

T/C	B/C	Plate
125	150	6C4
	200	8C4
	250	10C4
150	150	8C5
	200	8C5
	250	8C5
200	150	8C6
	200	8C6
	250	10C6
250	250	12C6

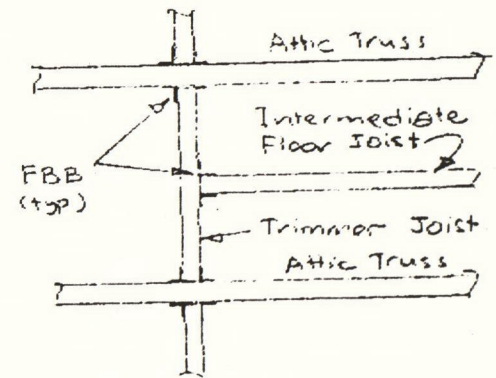

FLOOR JOIST FIXING  
PLAN VIEW

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Auckland 10


STANDARD ATTIC TRUSS DETAILS

DESIGNED:  
B.K. TIANG  
CHECKED:  
DATE:  
NOV. 1991



STANDARD ATTIC TRUSS

SHEET REF  
AT 2

2 AT 20/25,  
2 AT 25/25

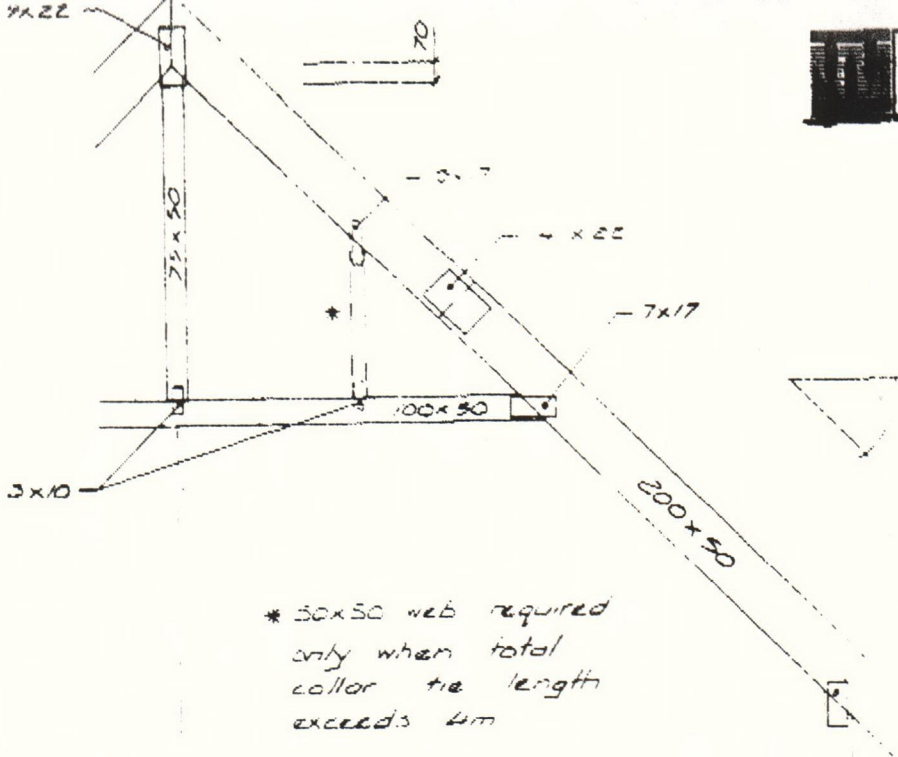

2 AT 20/25

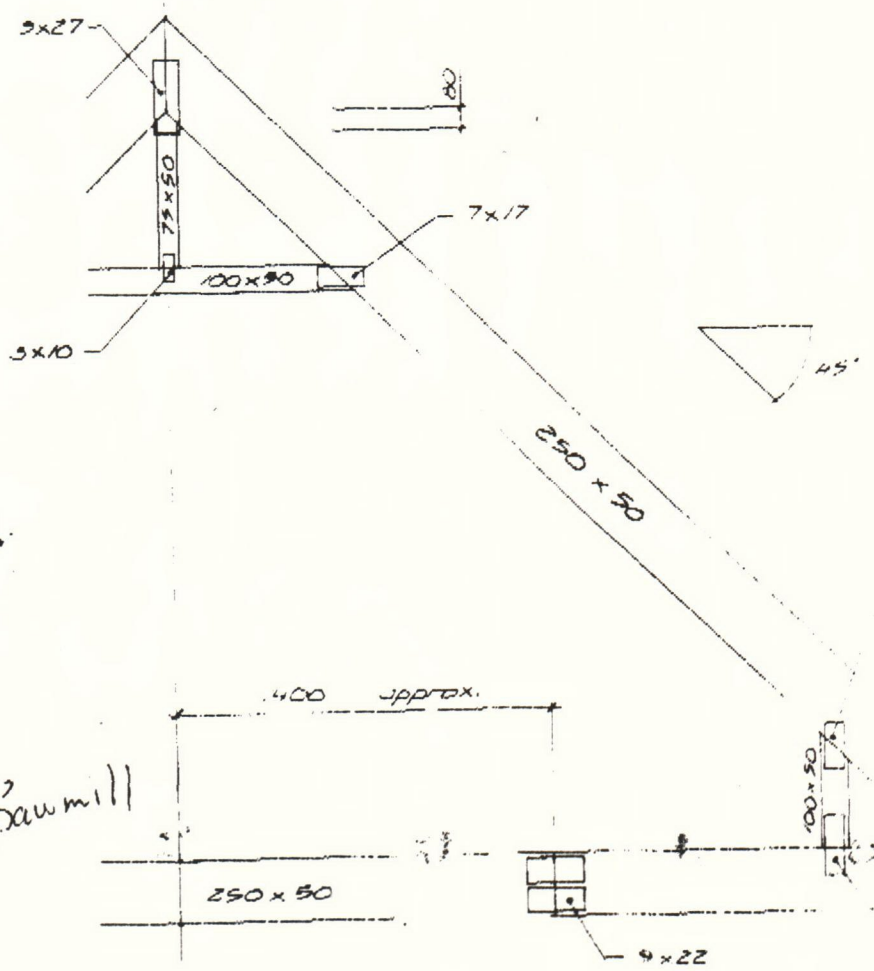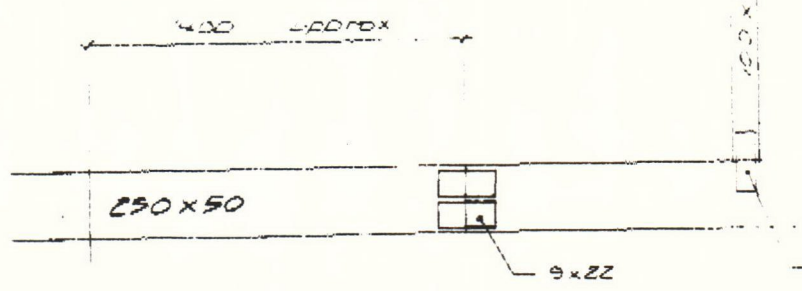

2 AT 25/25

*K V Sawmill*





## ATTIC TRUSS SELECTION TABLES


TWO SUPPORTS			2150 COLLAR TIE HEIGHT		2450 COLLAR TIE HEIGHT	
ROOF CLADDING	FLOOR SPAN	TRUSS CRS	TRUSS SPAN	TRUSS TYPE	TRUSS SPAN	TRUSS TYPE
light	3600	900	5600-6600	2 AT 20/20	5600-7700	2 AT 20/20 *
			6600-8200	2 AT 15/20	7700-8900	2 AT 15/20
heavy	3600	900	5600-7000	2 AT 20/20	5600-7700	2 AT 20/20
			7000-8200	2 AT 15/20	7700-8900	2 AT 15/20 W
light	4800	900	6000-7600	2 AT 25/25	6000-8200	2 AT 25/25
			7600-8400	2 AT 20/25	8200-9100	2 AT 20/25
			8400-9500	2 AT 15/25	9100-10100	2 AT 15/25
heavy	4800	900	6000-7700	2 AT 25/25	6000-8300	2 AT 25/25
			7700-8500	2 AT 20/25	8300-9100	2 AT 20/25
			8500-9500	2 AT 15/25 W	9100-10100	2 AT 15/25 W

THREE SUPPORTS			2150 COLLAR TIE HEIGHT		2450 COLLAR TIE HEIGHT	
ROOF CLADDING	FLOOR SPAN	TRUSS CRS	TRUSS SPAN	TRUSS TYPE	TRUSS SPAN	TRUSS TYPE
light	3600	900	5800-7200	3 AT 15/15	5800-8000	3 AT 15/15
			7200-8200	3 AT 12/15 W	8000-8800	3 AT 12/15 W
heavy	3600	900	5800-6600	3 AT 20/15	5800-7800	3 AT 20/15
			6600-8200	3 AT 15/15	7800-8900	3 AT 15/15 W
light	4800	900	6000-7200	3 AT 12/20	6000-7000	3 AT 12/20
			7200-9400	3 AT 15/20	7000-9200	3 AT 15/20
					9200-10000	3 AT 12/20 W
heavy	4800	900	6000-7000	3 AT 15/20	6000-6900	3 AT 15/20
			7000-9600	3 AT 20/20	6900-9000	3 AT 20/20
					9000-10100	3 AT 15/20 W

*R.V. Sawmill*

### LIMITS FOR POSITIONING OF CENTRAL SUPPORT

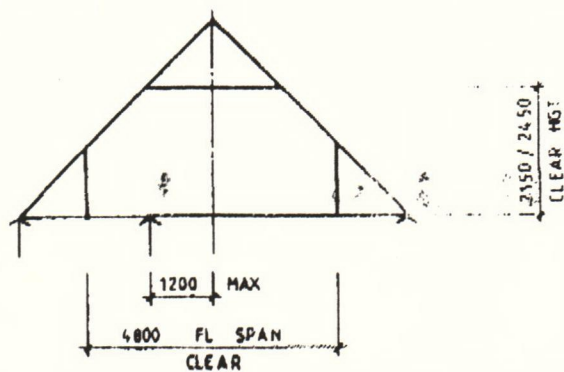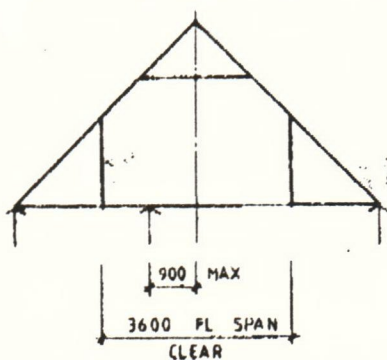

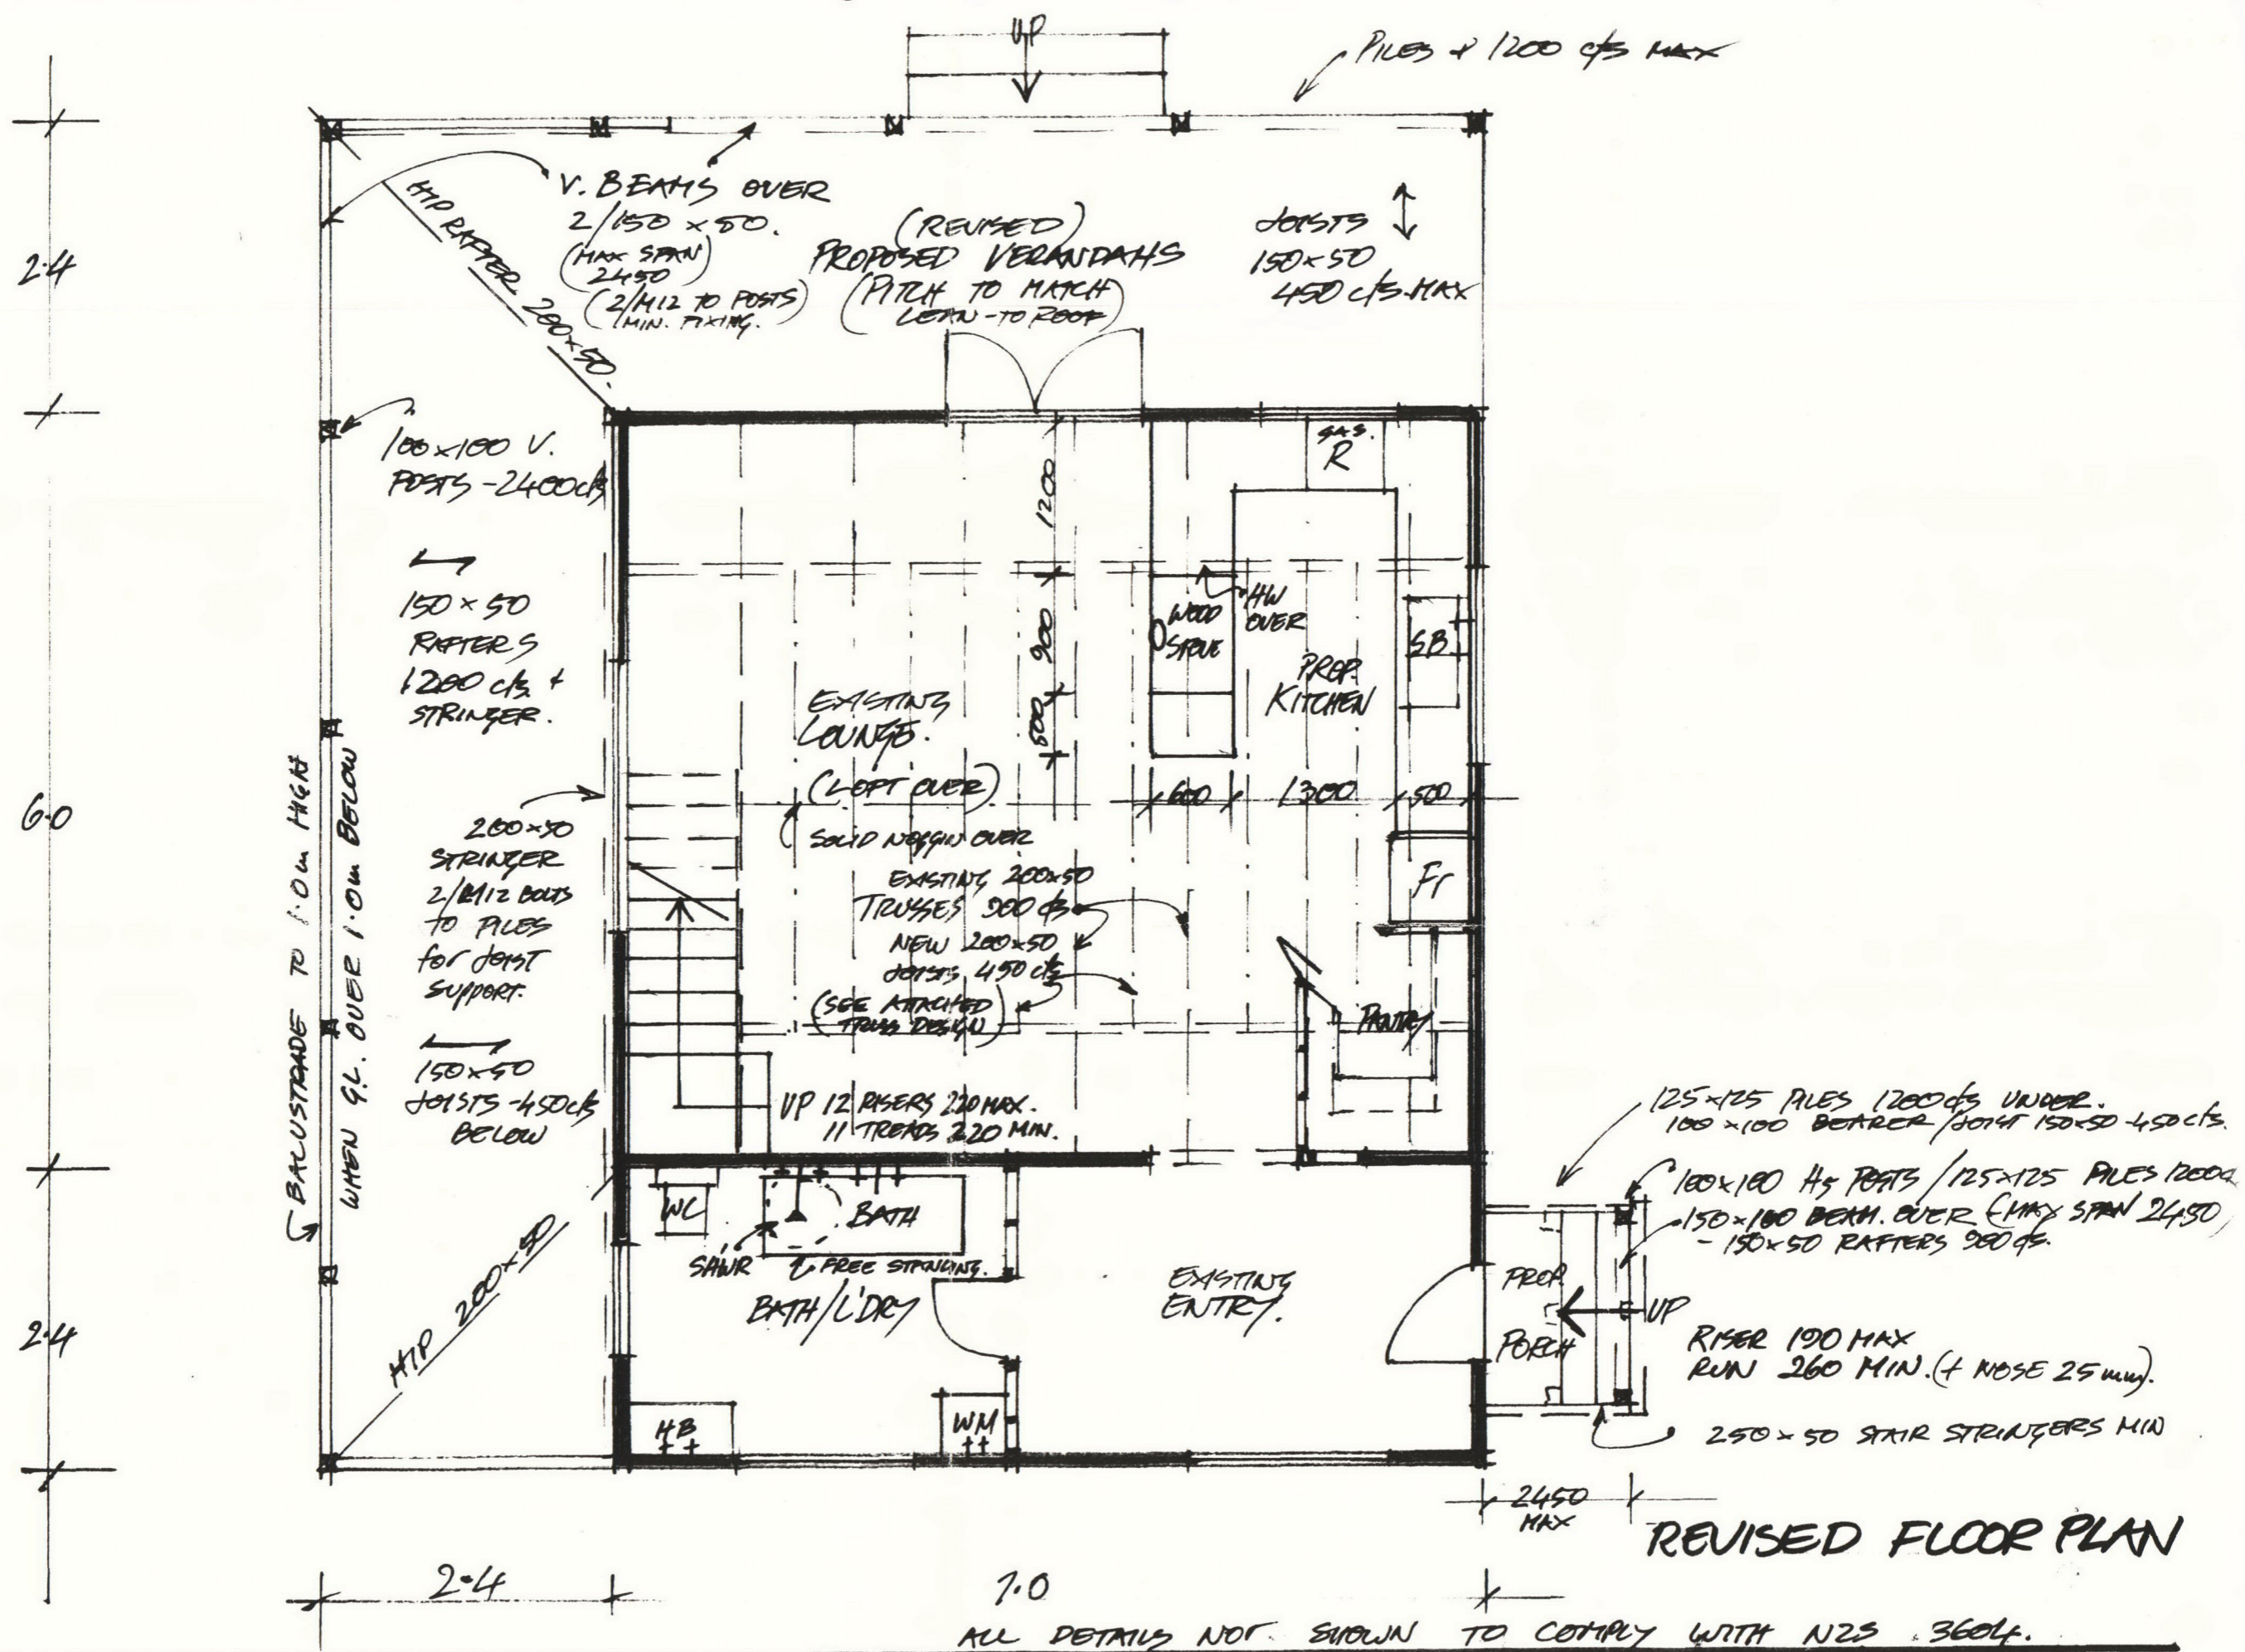


**REVISED FLOOR PLAN**


HANS MITT DESIGN  
BOX 29 OPONONI

A. LEHMANN HOUSE  
REVISIONS

FLOOR PLAN SHEET  
1:50 1

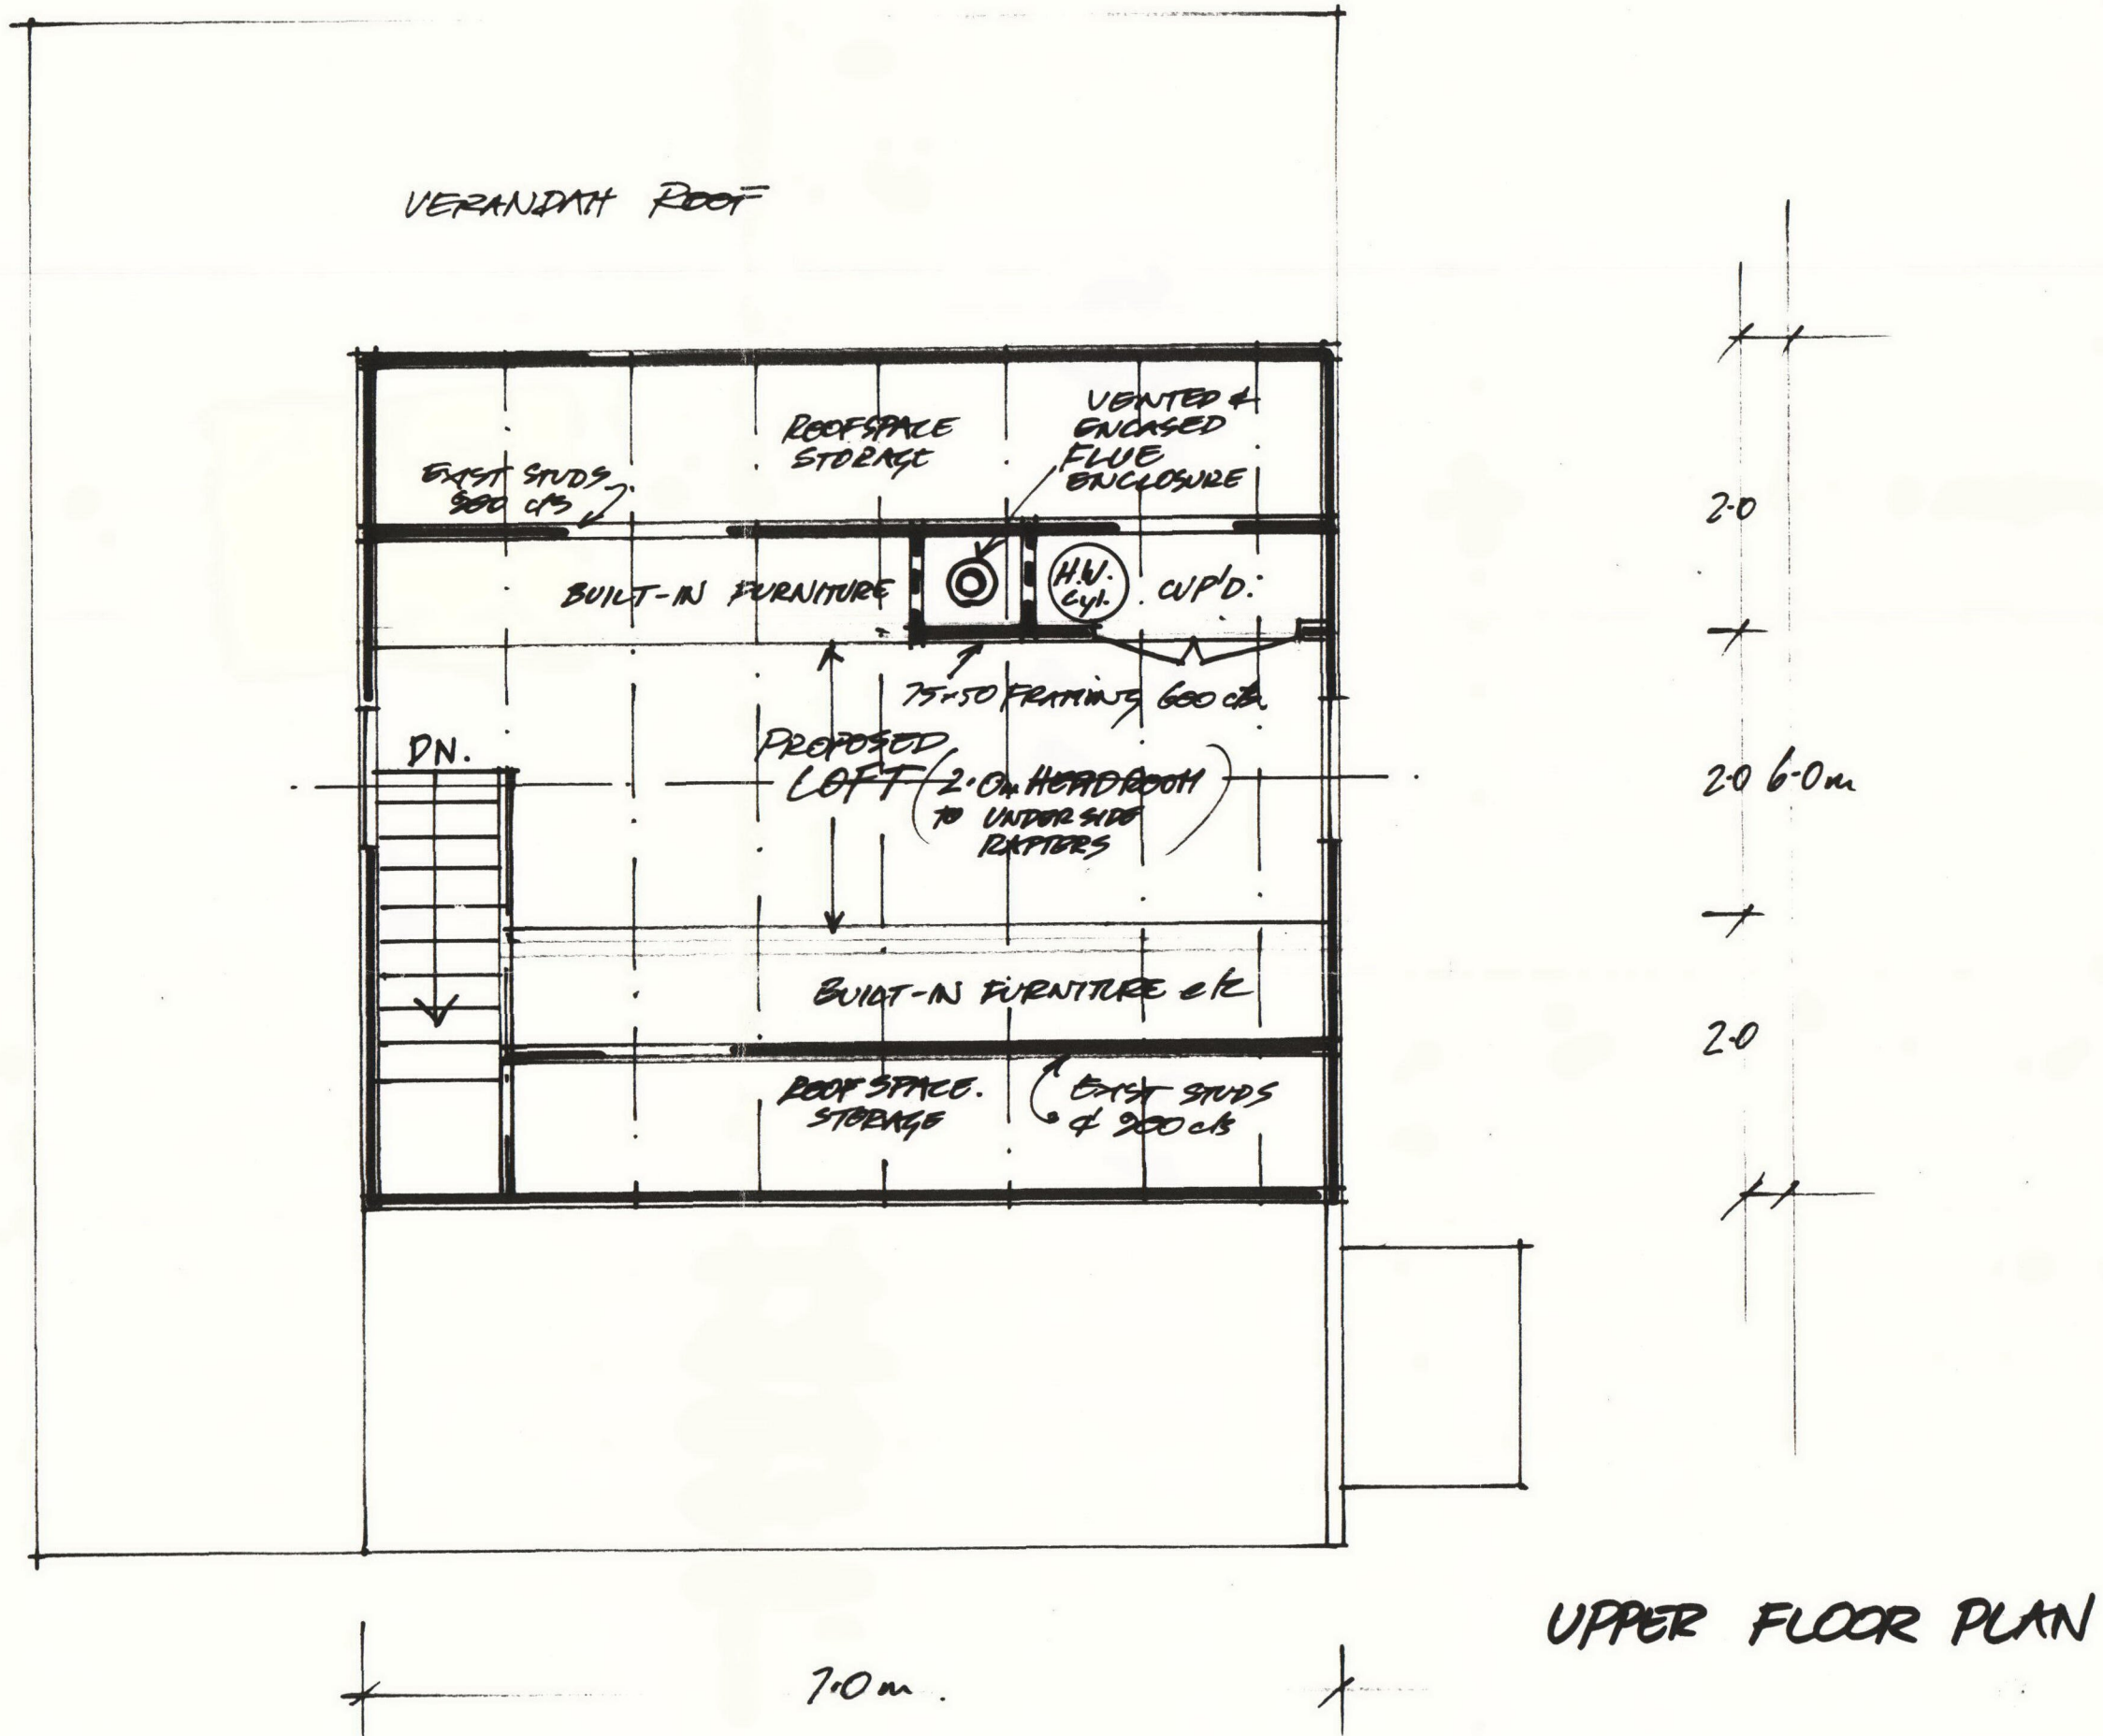

UPPER FLOOR PLAN

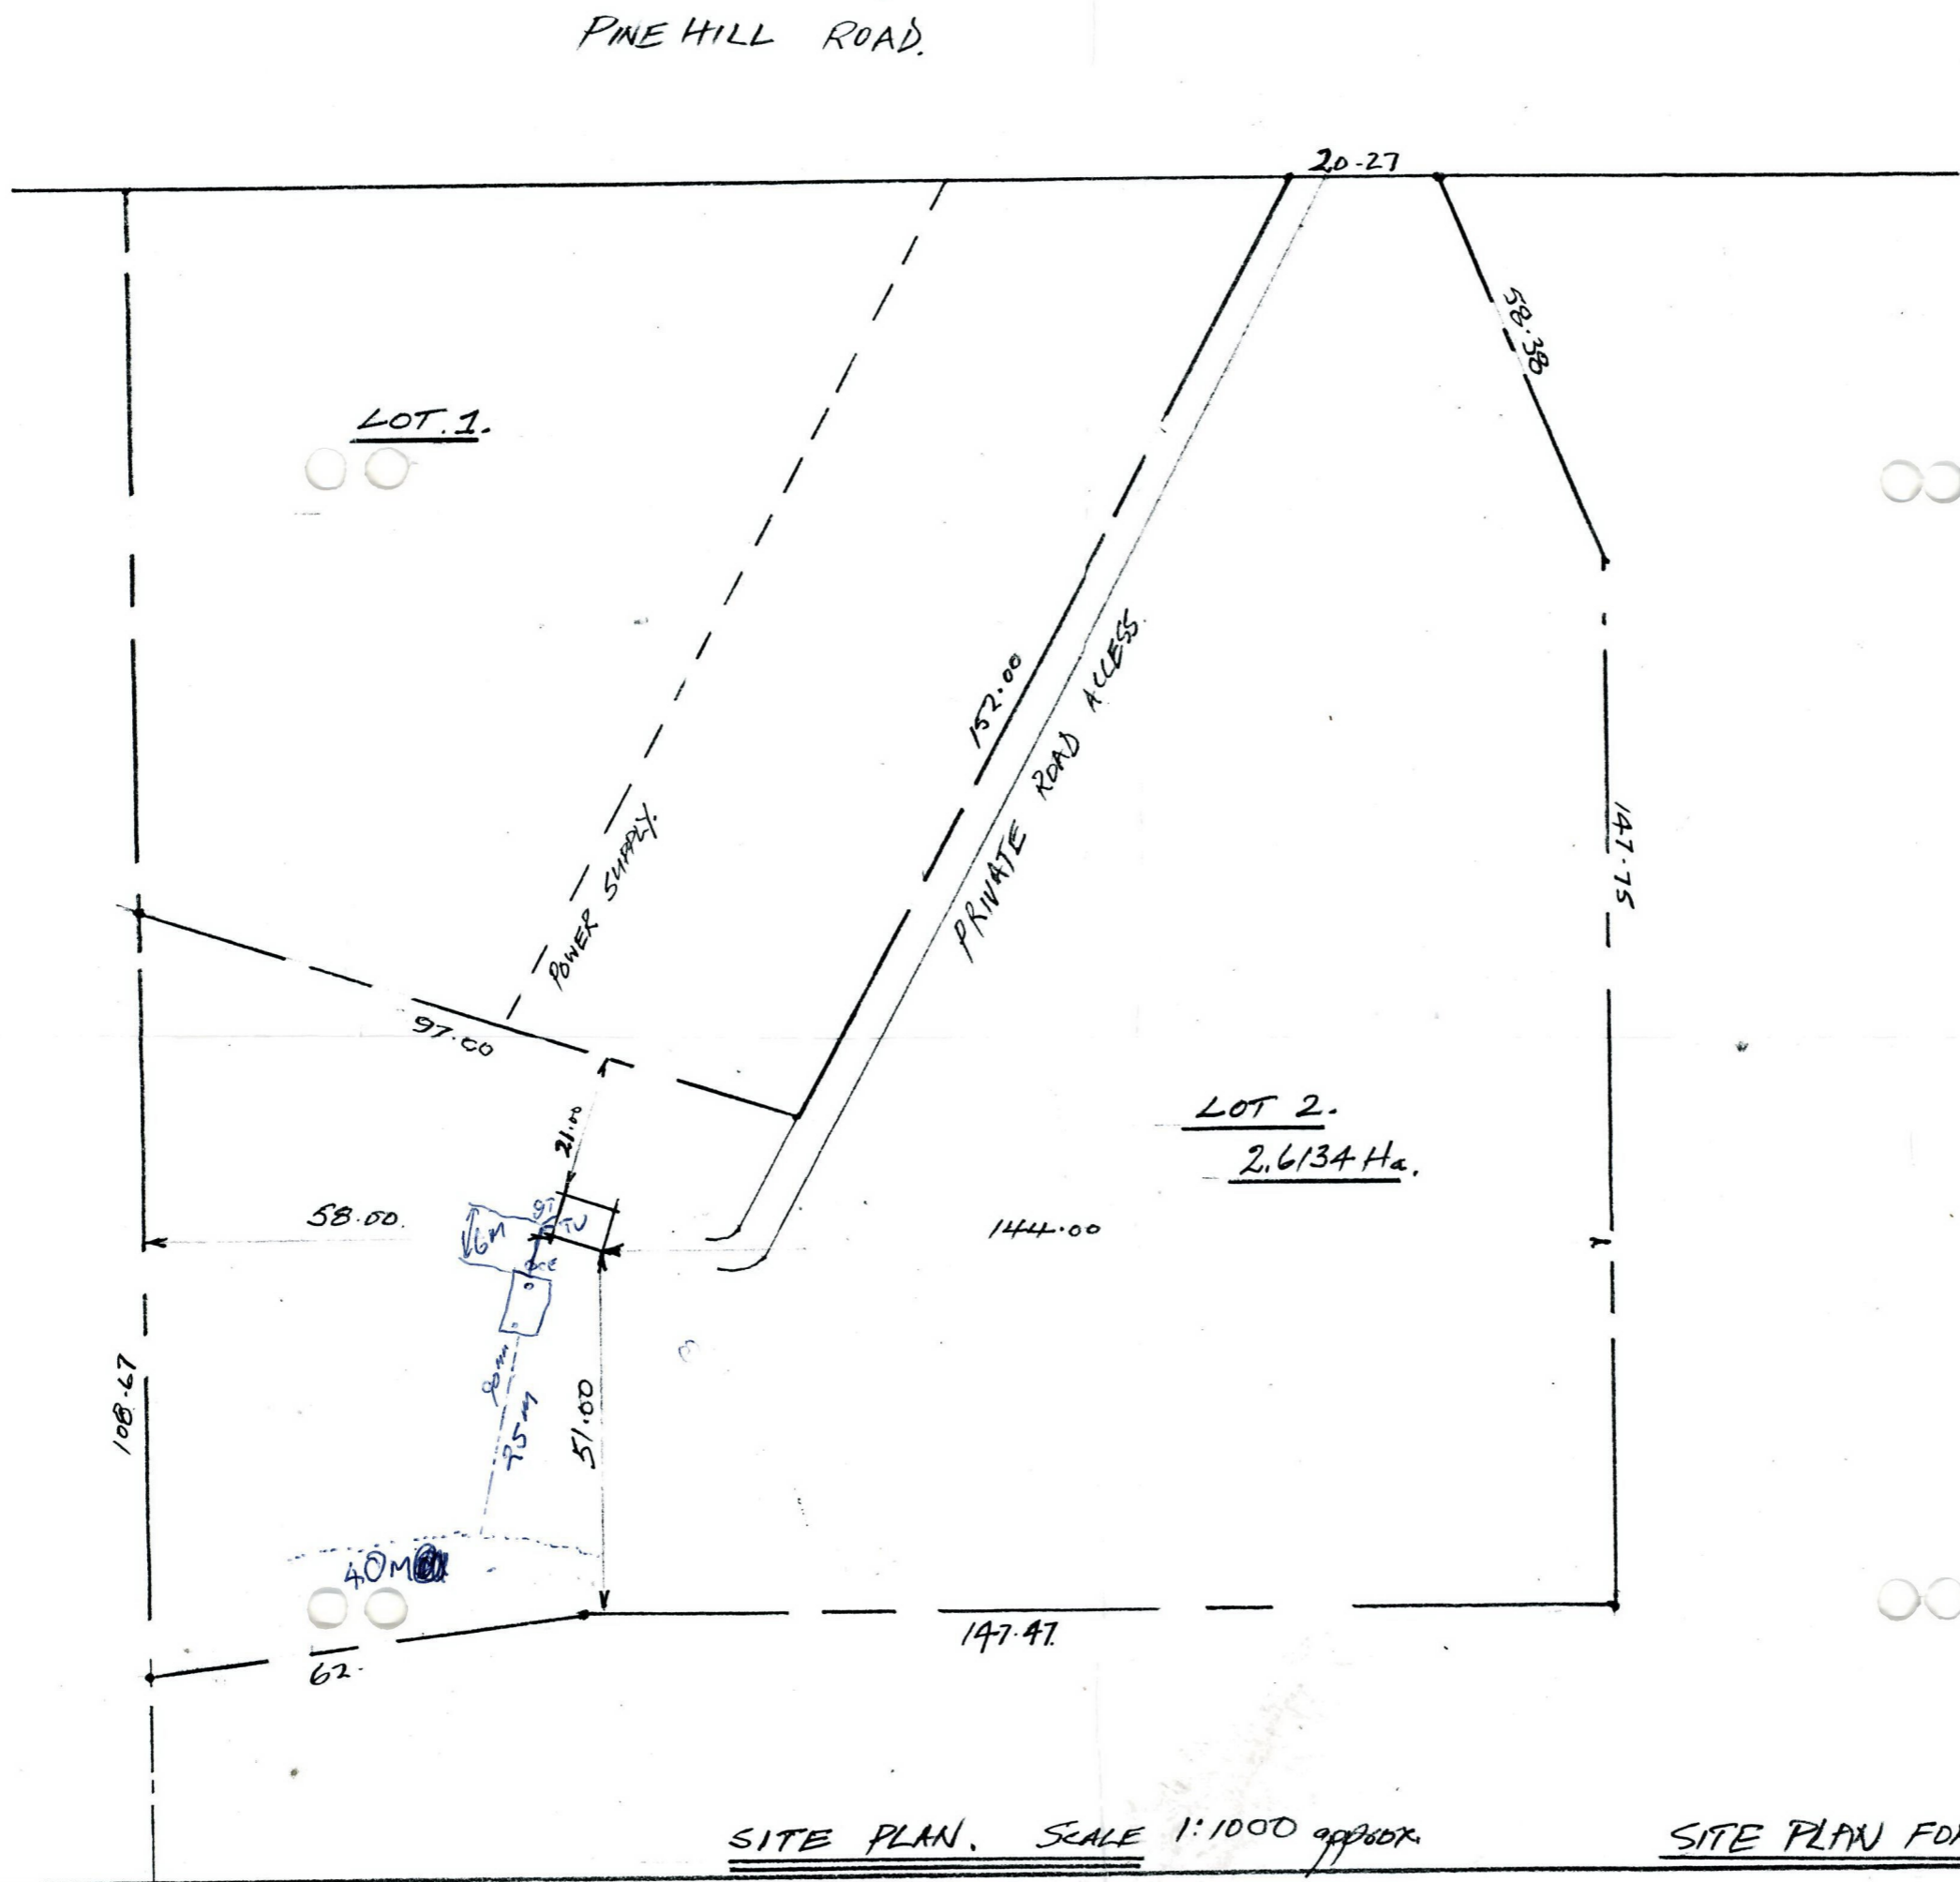

DRAINAGE PLAN DRAWN BY S. ARNOPP, CONTACT N° 09 4058 765.  
 TRUSS DESIGN KAIHU MILL — PRYDA COMPUTA.




BCPLA 1997-1417

RIDGE BOARD 250 x 50.

MATERIALS.

- 150x150 TAN/PILES HS.
- 100x100 BEARERS H4
- 150x50 FLOOR JOIST
- 100x50 FRAMING, HS
- 75x50 PURLINS
- 150x50 RAFTERS
- 300x25 FLOOR BOARD
- 300x25 SP/BOARD
- INTER. LINING - OWNER CHOSE
- EXT. LINING - BOARD + BATTEN
- BASE BOARD 150x25
- JOINER: WOODEN WINDOWS + DOORS, OWNERS CHOICE.
- FLOOR: T.G. 150x25 FLOORING

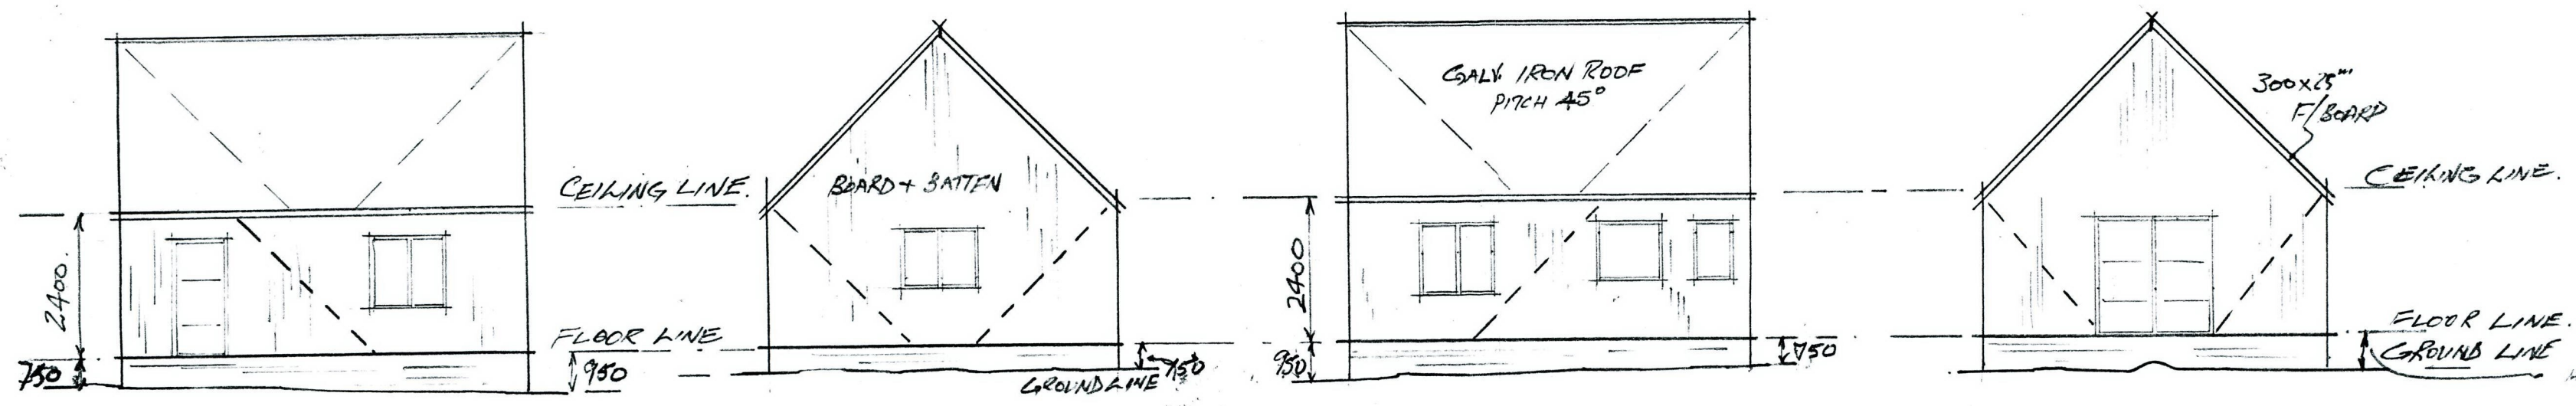


EAST ELEVATION


SOUTH ELEVATION

WEST ELEVATION


NORTH ELEVATION

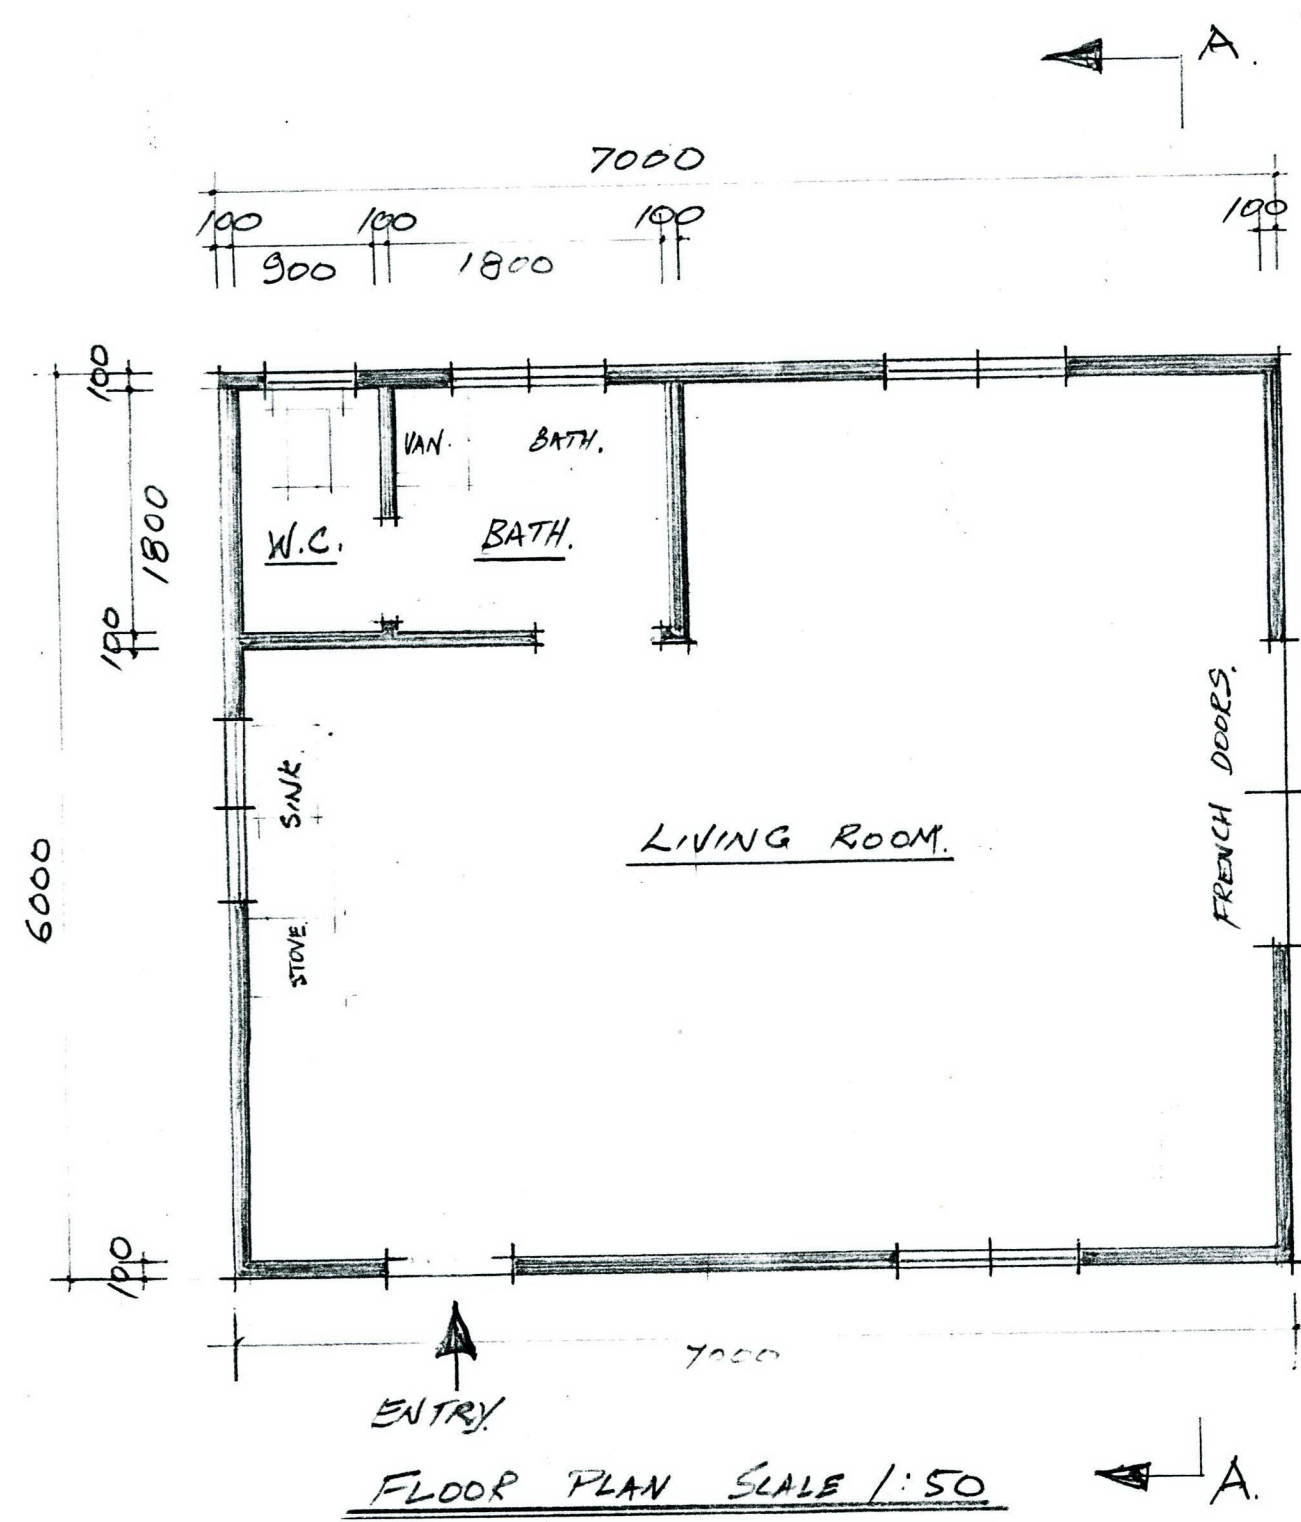

FLOOR PLAN SCALE 1:50

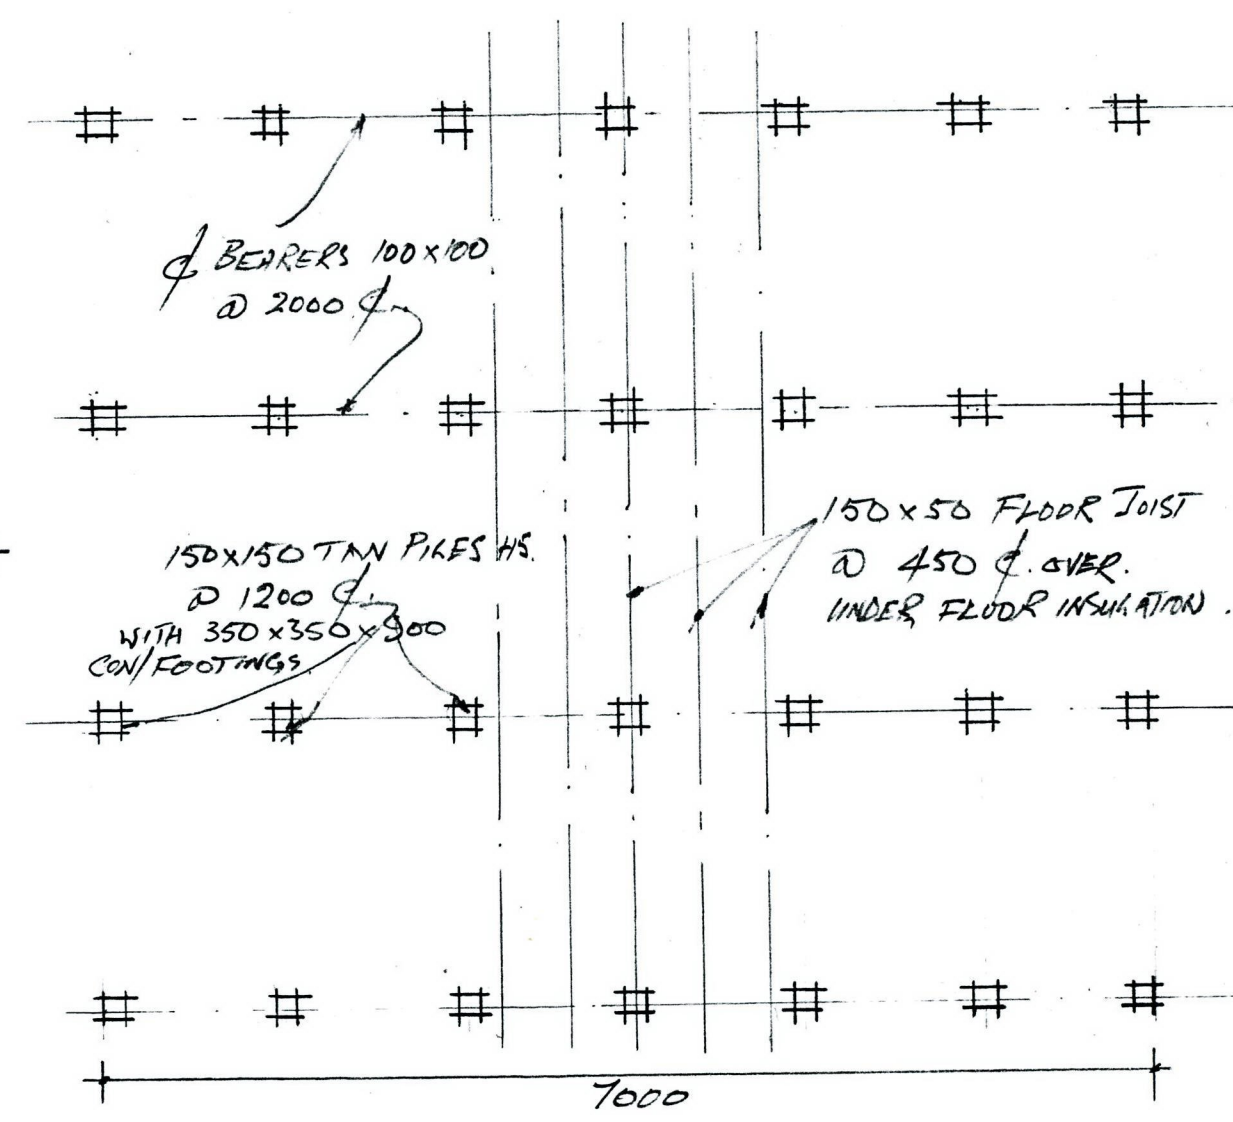


FOUNDATION PLAN SCALE 1:50

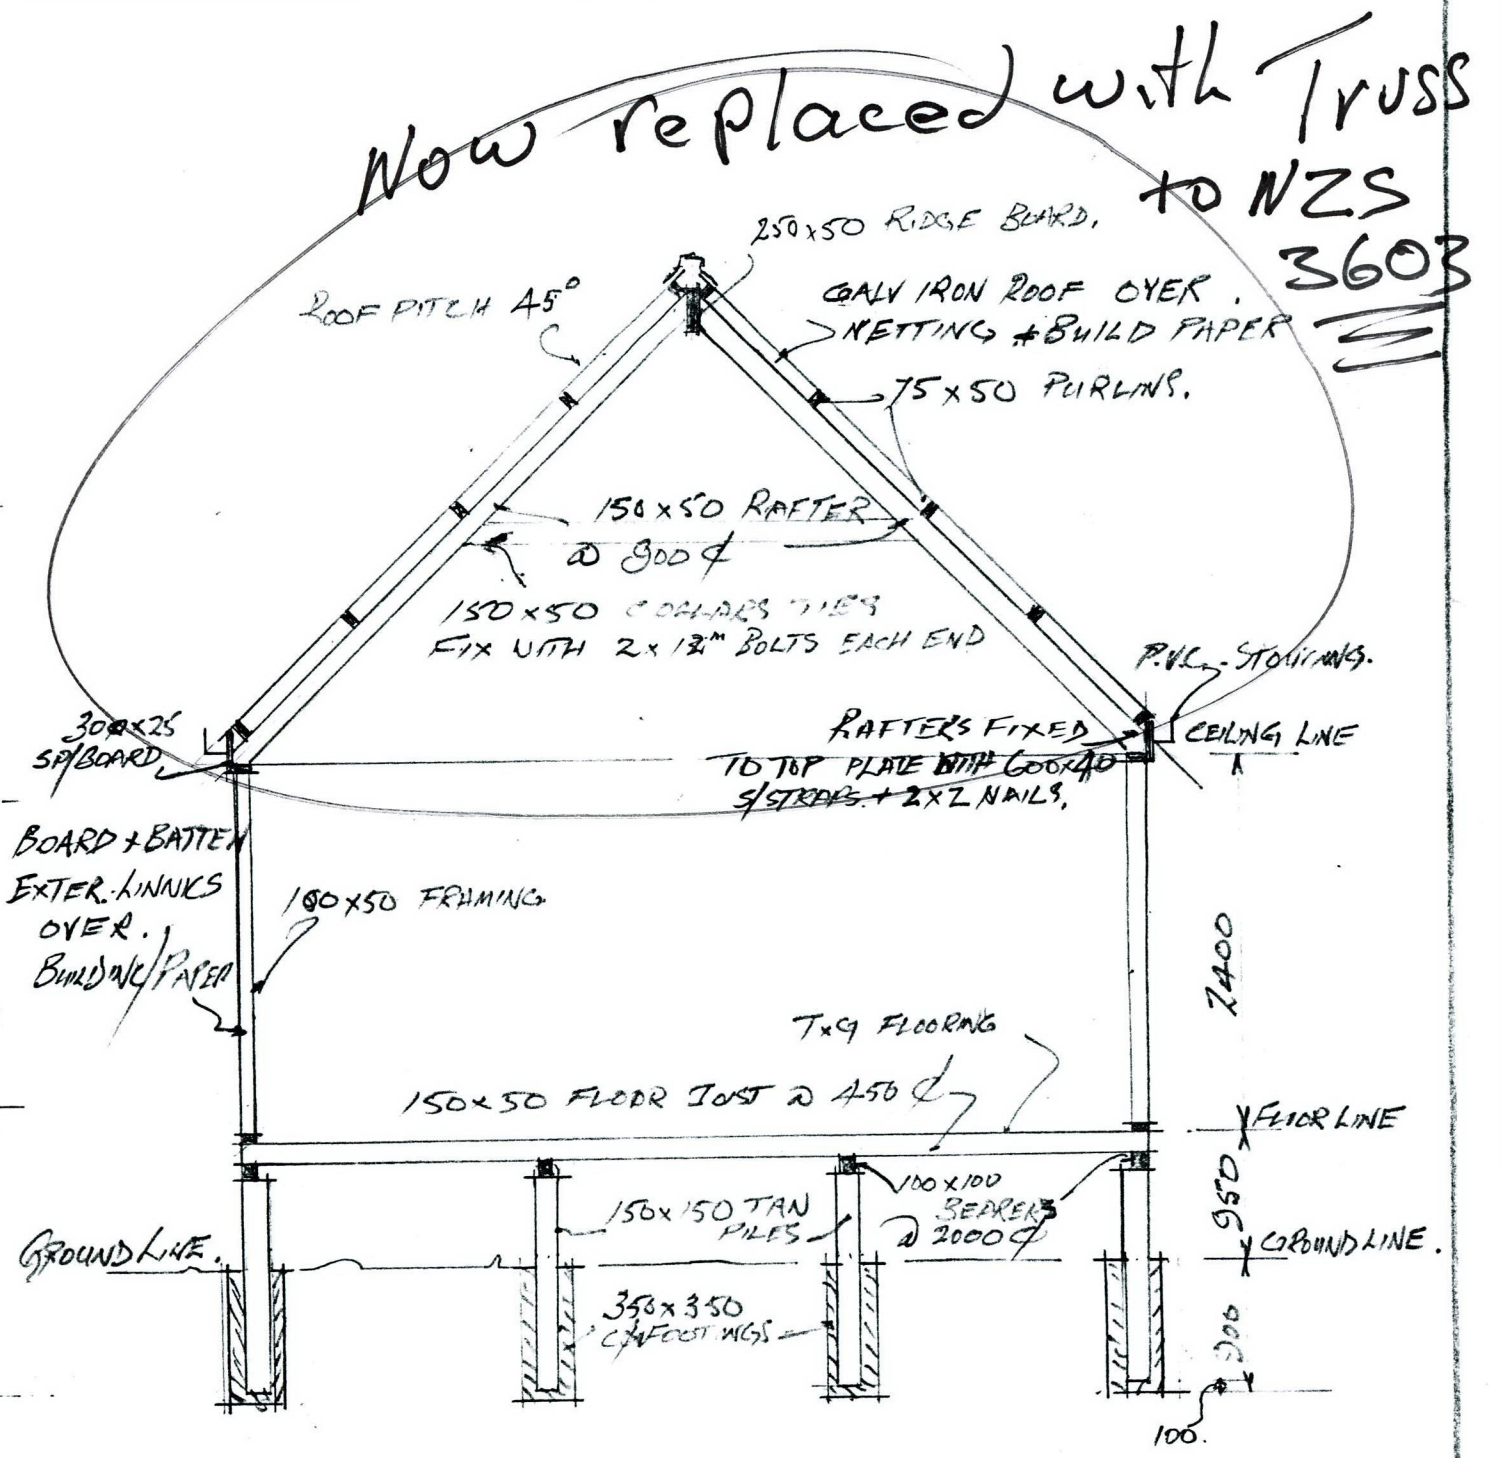

SECTION A-A. SCALE 1:50.

= PROPOSE RESIDENCE FOR. A. LEHMANN PINE HILL RD WATERHARANA, HOKIANGA. = DRAWN N. M. ANDERSON

PINE HILL ROAD

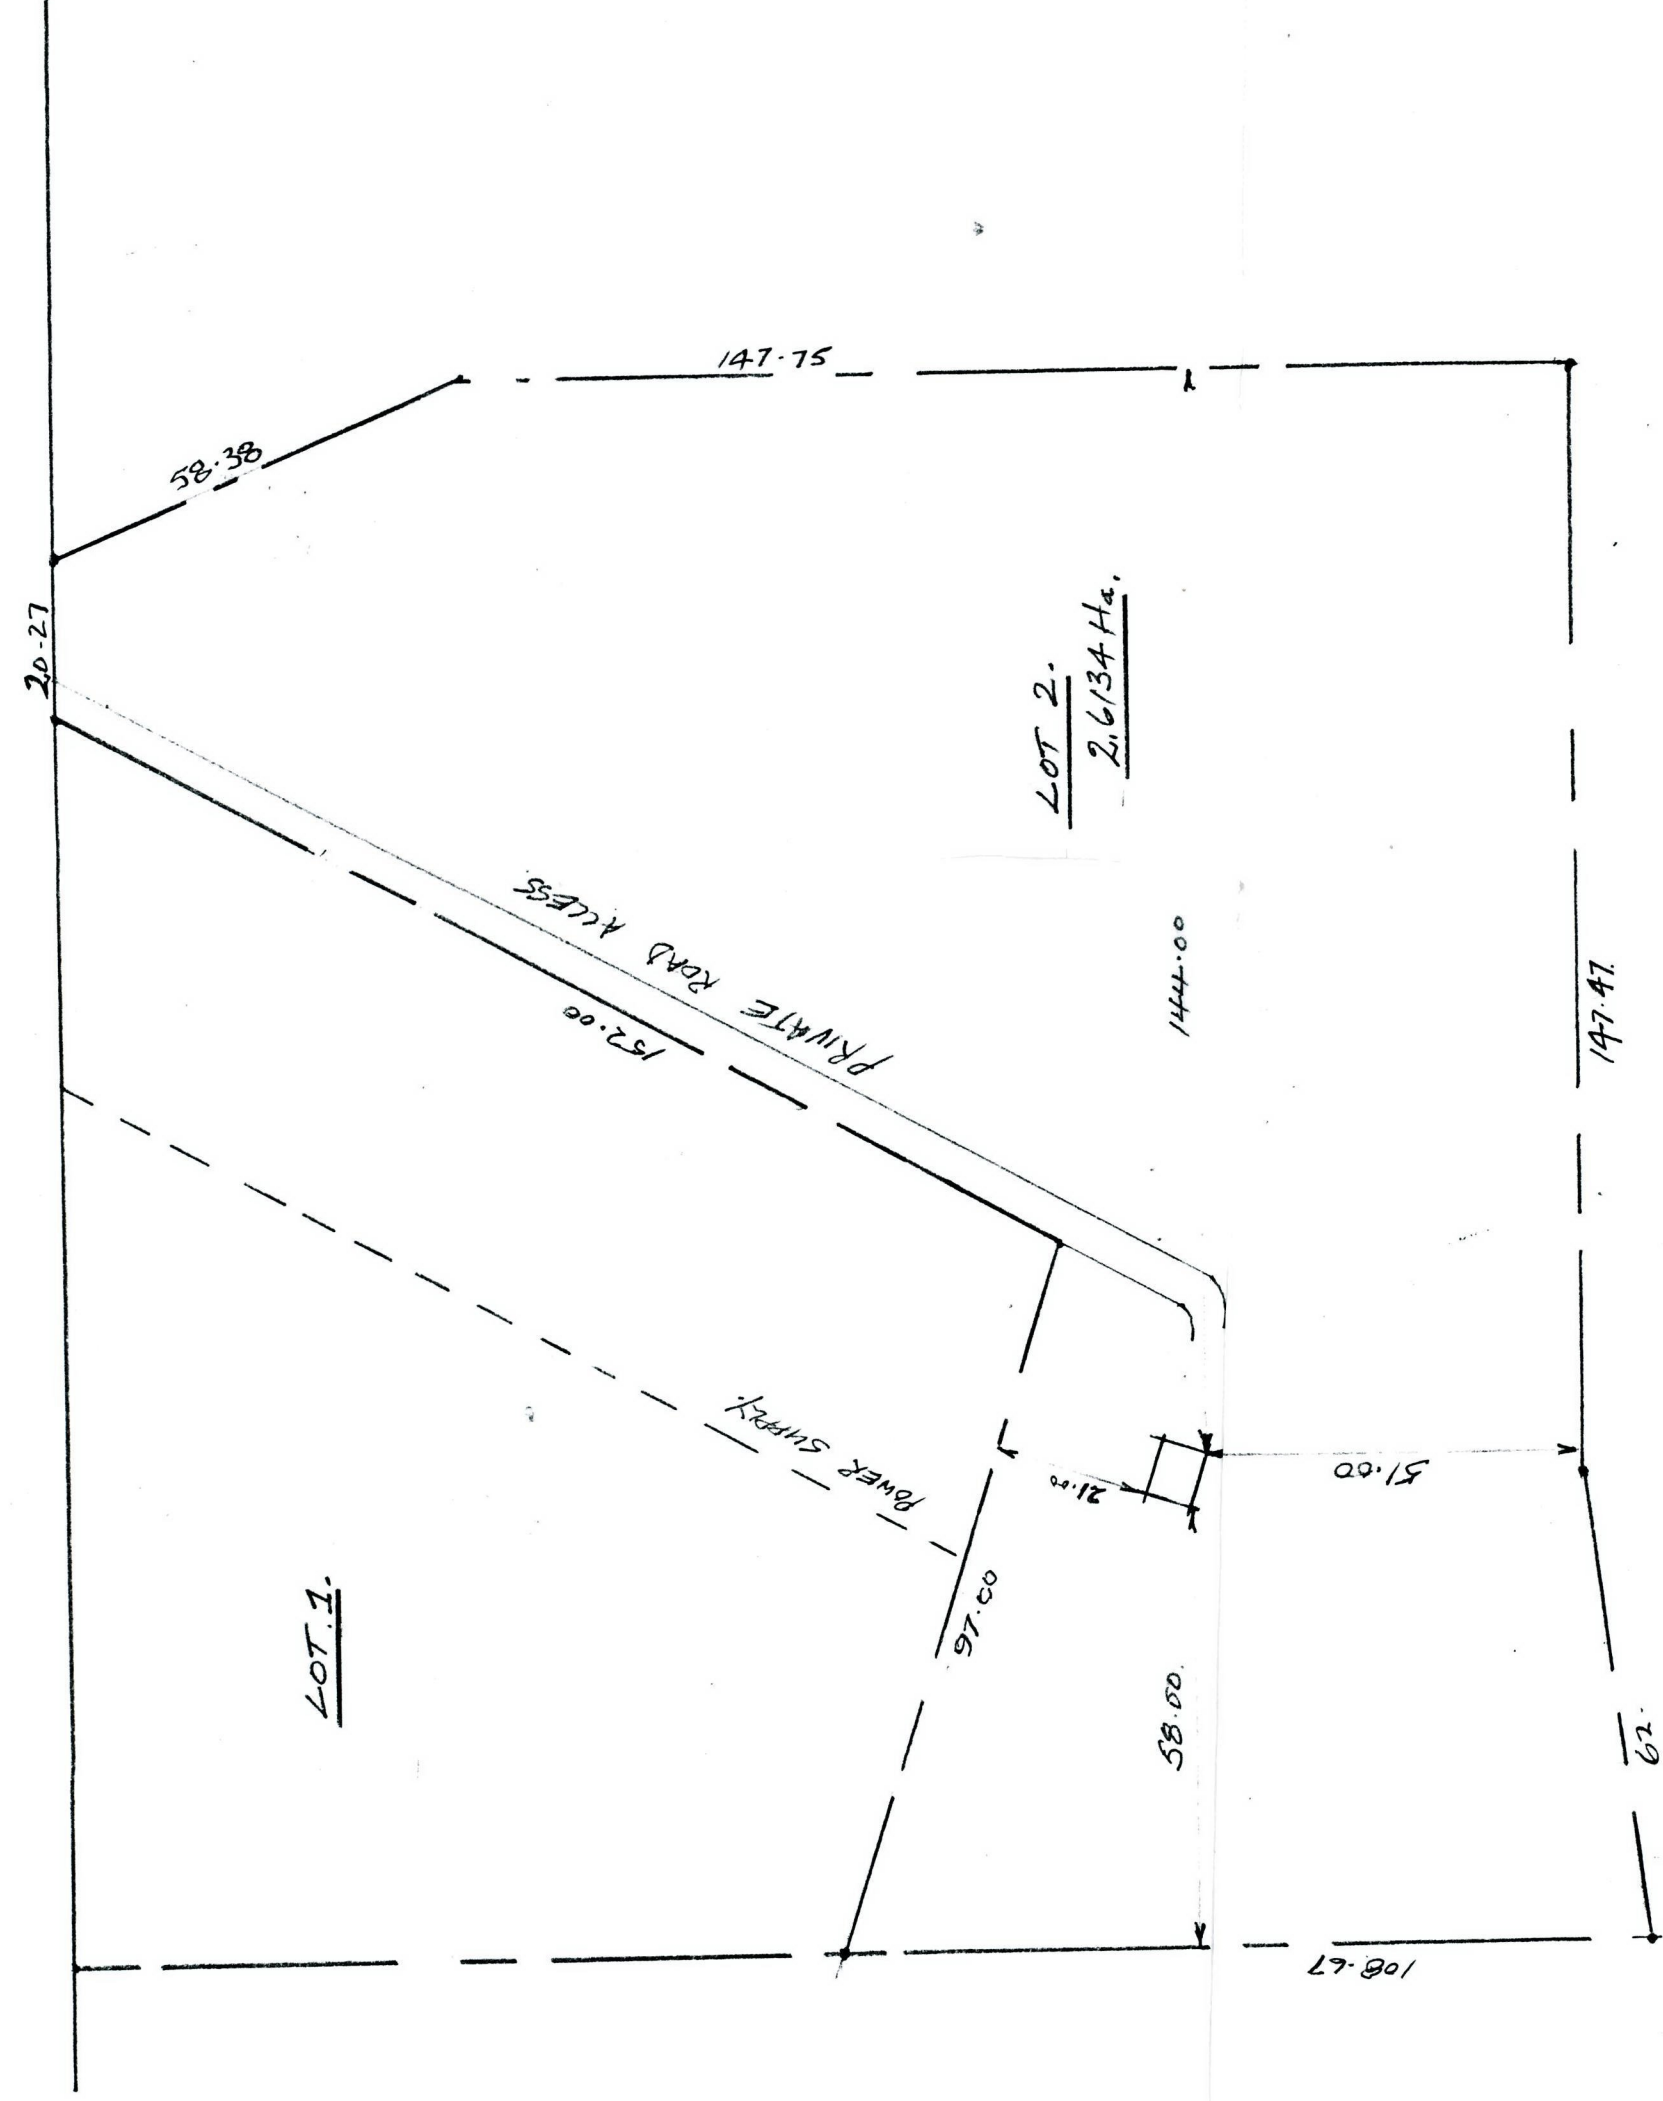

LOT 2.  
2.6134 Ha.

LOT 1.

PRIVATE ROAD ACCESS

POWER SURVEY

SITE PLAN FOR A. LEHMANN

SITE PLAN, SCALE 1:1000 APPROX